AMBER SPRING SR-80-2016 Feet 300 600 1,200

Zoning: **CX-3-PK**CAC: **Northeast**

Drainage Basin: Beaverdam Creek

Acreage: **2.29** Sq. Ft.: **52,264**

Planner: Michael Walters
Phone: (919) 996-2636
Applicant: Amber Spring

Housing Associates

Phone: (919) 848-2041





Administrative Approval Action

SR-80-16 / Amber Spring Transaction# 488675, AA# 3674 City of Raleigh Development Services One Exchange Plaza Raleigh, NC 27601 (919) 996-2626 DS.help@raleighnc.gov www.raleighnc.gov

REQUEST: Development of a 2.29 acre site (consisting of one parcel) zoned CX-3-PK into a 3

story, 52,268 square foot apartment building containing 42 dwelling units.

LOCATION: 5000 Spring Forest Road - This site consists of one parcel on the south side of Spring

Forest Road, west of the intersection of Spring Forest Road and Louisburg Road and

is inside of the city limits.

DESIGN ADJUSTMENTS/ ALTERNATES, ETC:

A Hardship Variance (A-54-17) was approved by the Board of Adjustment for this site

granting a 10' variance to the required 2' finish floor elevation of CX.

An Administrative Alternate was approved by the Planning Director for this project extending the 10'-55 Build To area allowing the façade of the building 85' from the right of way, also, allowing building façade in addition with amenity area to make up

the required 70% build to percentage of the lot width.

A Design Adjustment was approved waiving the block perimeter requirement and

allowing a variation on the street frontage cross section.

FINDINGS: City Administration finds that this request, with the below conditions of approval being

met, conforms to the Unified Development Ordinance. This approval is based on a

preliminary plan dated 8/18/2017 submitted by Timmons Group Inc.

CONDITIONS OF APPROVAL AND NEXT STEPS:

Prior to issuance of a land disturbing permit for the site:

1. That in accordance with Part 10A Section 9.4.4, a surety equal to of the cost of clearing, grubbing and reseeding a site, shall be paid to the City;

<u>Prior to the issuance of any site permits or approval of concurrent review process, whichever is applicable;</u>

- 2. That a 10' public access easement is to be shown on the plan in conjunction with the 5' pedestrian path;
- 3. That a final tree conservation plan with permit be approved by the Forestry Specialist. The plan must show metes and bounds descriptions of all tree conservation areas, and tree protection fence around all tree conservation areas.
- 4. That a stormwater control plan with a stormwater operations and maintenance manual and budget must be approved by the Stormwater Engineer in compliance with Chapter 9 of the Unified Development Ordinance, including the designation of buffer areas and open space areas for stormwater purposes, and the total costs of the stormwater control measures and those amounts equal to 24% and 125% respectively, prior to grading or the approval of construction drawings whichever event comes first;



Administrative Approval Action

SR-80-16 / Amber Spring Transaction# 488675, AA# 3674 City of Raleigh
Development Services
One Exchange Plaza
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5. That a nitrogen offset payment must be made to a qualifying mitigation bank;

Prior to issuance of building permits:

- 6. That ½ of the required 104' of right-of-way for Spring Forest Road must be dedicated to the City of Raleigh and a copy of the recorded map be provided to the City;
- 7. That all stormwater control measures and means of transporting stormwater runoff to and from any nitrogen and stormwater runoff control measures shall be shown on all plats and recorded as private drainage easements;
- 8. That a tree conservation map be recorded with metes and bounds showing the designated Tree Conservation Areas in compliance with Chapter 9 of the Unified Development Ordinance;
- 9. That a driveway permit and encroachment agreement from the North Carolina Department of Transportation is to be provided;
- 10. That a 5' public pedestrian cross access easement running from north to south and a 10' public pedestrian cross access easement running from east to west is shown on all maps for recording to accommodate a 5' ADA-accessible pedestrian path within them as shown on the preliminary plan, and a copy of the recorded map be provided to the City;
- 11. That a cross access agreement among the proposed lot owned by AMBER SPRING HOUSING ASSOCIATES, LLC, NORWOOD, HUBERT L NORWOOD, SHIRLEY D, and SPRINGHILL SHOPPING LLC lot is approved by the Development Services Department for recording in the Wake County Registry, and that a copy of the recorded cross access easement be returned to the City within 1 day of recording;
- 12. That in accordance with UDO Section 8.1.3, a surety equal to incomplete public improvements as 125% of construction costs for City improvements and 100% of construction costs for NCDOT improvements is paid to the Development Services Department, Development Engineering Division;
- 13. That in accordance with UDO Section 9.2.2, a surety equal to 125% of the cost of construction of a stormwater device must be paid to the City;
- 14. That the developer must pay the City a stormwater facility replacement fund payment equal to 24% of the estimated cost of constructing all stormwater control facilities;
- 15. That right-of-way obstruction permits must be obtained for any construction activity within the right-of-way;

Prior to issuance of building occupancy permit:

- 16. That all street lights and street signs that are required as part of the development approval, and for public safety, shall be coordinated with the proper authority and installed;
- 17. That in accordance with UDO Section 9.2.2, an as-built plan and certification for any stormwater control device shall be reviewed and accepted by the City.



Administrative Approval Action

SR-80-16 / Amber Spring Transaction# 488675, AA# 3674

City of Raleigh **Development Services** One Exchange Plaza Raleigh, NC 27601 (919) 996-2626 DS.help@raleighnc.gov www.raleighnc.gov

EXPIRATION DATES: The expiration provisions of UDO Section 10.2.8 E, including the ability to request extensions in the expiration date, apply to this site plan. To avoid allowing this plan approval to expire, the following must take place by the following dates:

3-Year Expiration Date: 9-13-2020

Obtain a valid building permit for the total area of the project, or a phase of the project.

4-Year Completion Date:

Within four years after issuance of the first building permit for the site plan, the construction of the entire site plan must be completed unless an applicant has been granted vested rights. Failure to complete construction within this specified time frame shall automatically void the approved site plan for which no building permits have been issued.

I hereby certify this administrative decision. (Planning Dir.) Kenneth Romers Signed: Staff Coordinator: Michael Walters

PRELIMINARY SITE PLAN REVIEW AMBER SPRING - A SENIOR LIVING COMMUNITY

SR-80-16 TRANSACTION # 488675

5000 SPRING FOREST ROAD (SR 2041) RALEIGH, NORTH CAROLINA 27616 WAKE COUNTY

ARCHITECT:

MAURER ARCHITECTURE 119 E HARGETT STREET RALEIGH, NC 27601 PH. (919) 829-4969 FAX (919) 829-0860 BECKY@MAURERARCHITECTURE.COM

OWNER/DEVELOPER:

AMBER SPRING HOUSING ASSOCIATES, LLC 7706 SIX FORKS ROAD RALEIGH, NC 27615 PH. (919) 848-2041 FAX (919) 848-0455 TIM@SPECTRUM-EVERGREEN.COM

CIVIL ENGINEER:

TIMMONS GROUP RICK BAKER, P.E. 5410 TRINITY ROAD; SUITE 102 RALEIGH, NC 27607 PH: (919) 866-4939 RICK.BAKER@TIMMONS.COM

SITE PLAN SUMMARY

PROJECT: AMBER SPRING - A SENIOR LIVING COMMUNITY OWNER: AMBER SPRING HOUSING ASSOCIATES, LLC PROJECT ADDRESS: 5000 SPRING FOREST RD. RALEIGH, NC 27616 1736 06 8507

DEED: DB 4325 PG 3 CX-3-PK **EXISTING USE: VACANT**

PROPOSED USE: SENIOR HOUSING

NOT LOCATED IN FLOOD HAZARDS AREA PER FLOOD ZONE: FEMA MAP #3720173600J (05-02-2006)

TOTAL EXISTING TRACT AREA: **2.29 ACRES**

TRANSACTION NUMBER: 488675 (SR-80-16)

21 ONE BEDROOM APARTMENTS UNITS:

21 TWO BEDROOM APARTMENTS

VEHICLE PARKING SUMMARY: REQ'D (46 SPACES): PER U.D.O. SEC. 7.1.4.C

1 SPACE /UNIT + 1 SPACE/10 UNITS (SEC 7.1.4C) 42 SPACES + 4 SPACES = 46 SPACES REQ'D

40 SPACES ON SITE + 13 OFF SITE AGREEMENT PROV'D (53 SPACES): OFFSITE AGREEMENT (BK 5097; PG 815) WITH

SPRINGHILL SHOPPING CENTER PIN #1736-16-0212 ADA: 3 REQ'D;8 PROV'D W/ 2 VAN ACCESSIBLE

BICYCLE PARKING SPACES

42 UNITS/20 = 2 SPACES (USE 4 SPACE MIN)


4 SPACES PROV'D:

AMENITY AREA:

9.975 SF REQ'D AND 10.130 SF PROV'D

1 SPACE/20 UNITS WITH (4) MIN. (SEC 7.1.2C)


APPROVED HARDSHIP VARIANCE (CASE NUMBER A-54-17)

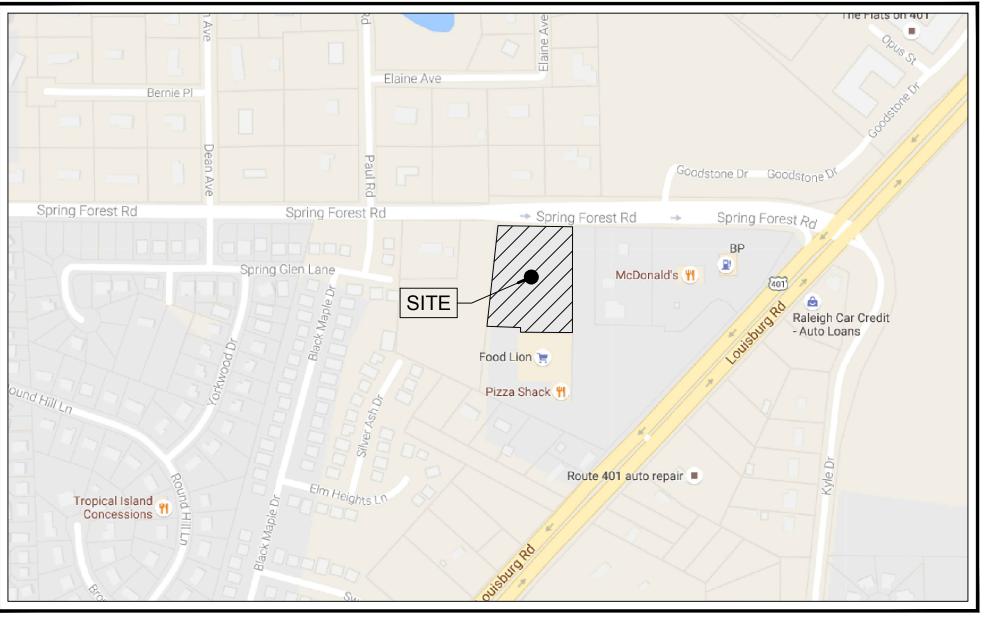

VICINITY MAP NTS

Sheet Number	Sheet Title
C0.0	COVER SHEET
C1.0	EXISTING CONDITIONS
C2.0	SITE LAYOUT PLAN
C2.1	FIRE TRUCK ACCESS PLAN
C2.2	WASTE SERVICES ACCESS PLAN
C3.0	GRADING AND DRAINAGE PLAN
C3.1	SPRING FOREST ROAD STORMWATER PLAN
C5.0	UTILITY PLAN
C6.0	LANDSCAPE PLAN
TCA1.0	TREE CONSERVATION AREA PLAN
C7.0	DETAILS
C7.1	DETAILS
C7.2	DETAILS
C7.3	DETAILS
A1.1	ARCHITECTURAL FLOOR PLAN
A2.1	ARCHITECTURAL ELEVATIONS

Sheet List Table

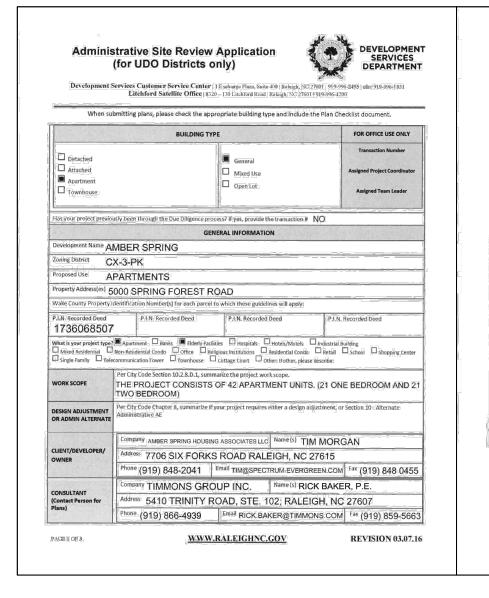

DEVELOPMENT TYPE & SITE DATA	TABLE (Applie	able to all developments)		
Zoning Information	Building Information			
Zoning District(s) CX-3-PK	Proposed building use(s) APARTMENTS			
f more than one district, provide the acreage of each	Existing Building(s) sq. ft. gross -			
Overlay District	Proposed Building(s) sq.ft. gross - 52, 267, 5 SF			
otal Site Acres 2.29 Inside City Limits Yes No of Site	Total sq. ft. gross (existing & proposed) - 52, 267, 53			
Off street parking Required Provided 46 REQ/D/46 PROV	Proposed height of building(s) = 42 Stories = 3			
OA (Certificate of Appropriateness) case #	FAR (floor area ratio percentage) - 58,5%			
OA (Board of Adjustment) case # A 54-17		Building Lot Coverage percentage 57% (site plans only)		
UD (Conditional Use District) case # Z-		Height of 1st Floor - /z"		
Stormwat	er Information			
xisting Impervious Surface 0,21acres/square feet		Flood Hazard Area Yes No		
roposed Impervious Surface 1.29 acres/square feet		If Yes, please provide:		
euse River Buffer Yes No Wetlands Yes No		Alluvial Soils Flood Study FEMA Map Panel # 3720173600J		
FOR RESIDENTIA	AL DEVELOPN	MENTS		
Total # Of Apartment, Condominium or Residential Units 42	5. Bedroor	n Units 1br,21 2br 21 βbr - 4br or more		
Total # Of Congregate Care Or Life Care Dwelling Units N/A	6. Infill Development 2.2.7 N/A			
Total Number of Hotel Units N/A	7. Open Sp	7. Open Space (prily) or Amenity -		
Overall Total # Of Dwelling Units (1-6 Above) 42	8. Is your p	8. Is your project a cluster unit development? Yes No		
SIGNATURE BLOCK (App	licable to all	developments)		
filling this plan as the property owner(s). I/we do hereby agree and fill assigns fointly and severally to construct all improvements and majoroved by the City; ereby designate elve and respond to administrative comments, to resubmit plans on discation. The bave read, acknowledge and affirm that this project is conforming to the comments of the conforming to the confo	ke all dedication P, INC. my behalf and	ns as shown on this proposed development, plan as to serve as my agent regarding this application, to to represent me in any public meeting regarding this		
ned		Date		



PRELIMINARY - NOT RELEASED FOR CONSTRUCTION

ALL CONSTRUCTION TO BE IN ACCORDANCE WITH ALL CITY OF RALEIGH. NCDEQ AND NCDOT STANDARDS, SPECIFICATIONS, AND DETAILS

09/14/16


P. BARBEAL **DESIGNED BY** P. BARBEAU

CHECKED BY R. BAKER

PER PLAN

36311


SHEET NO. C0.0

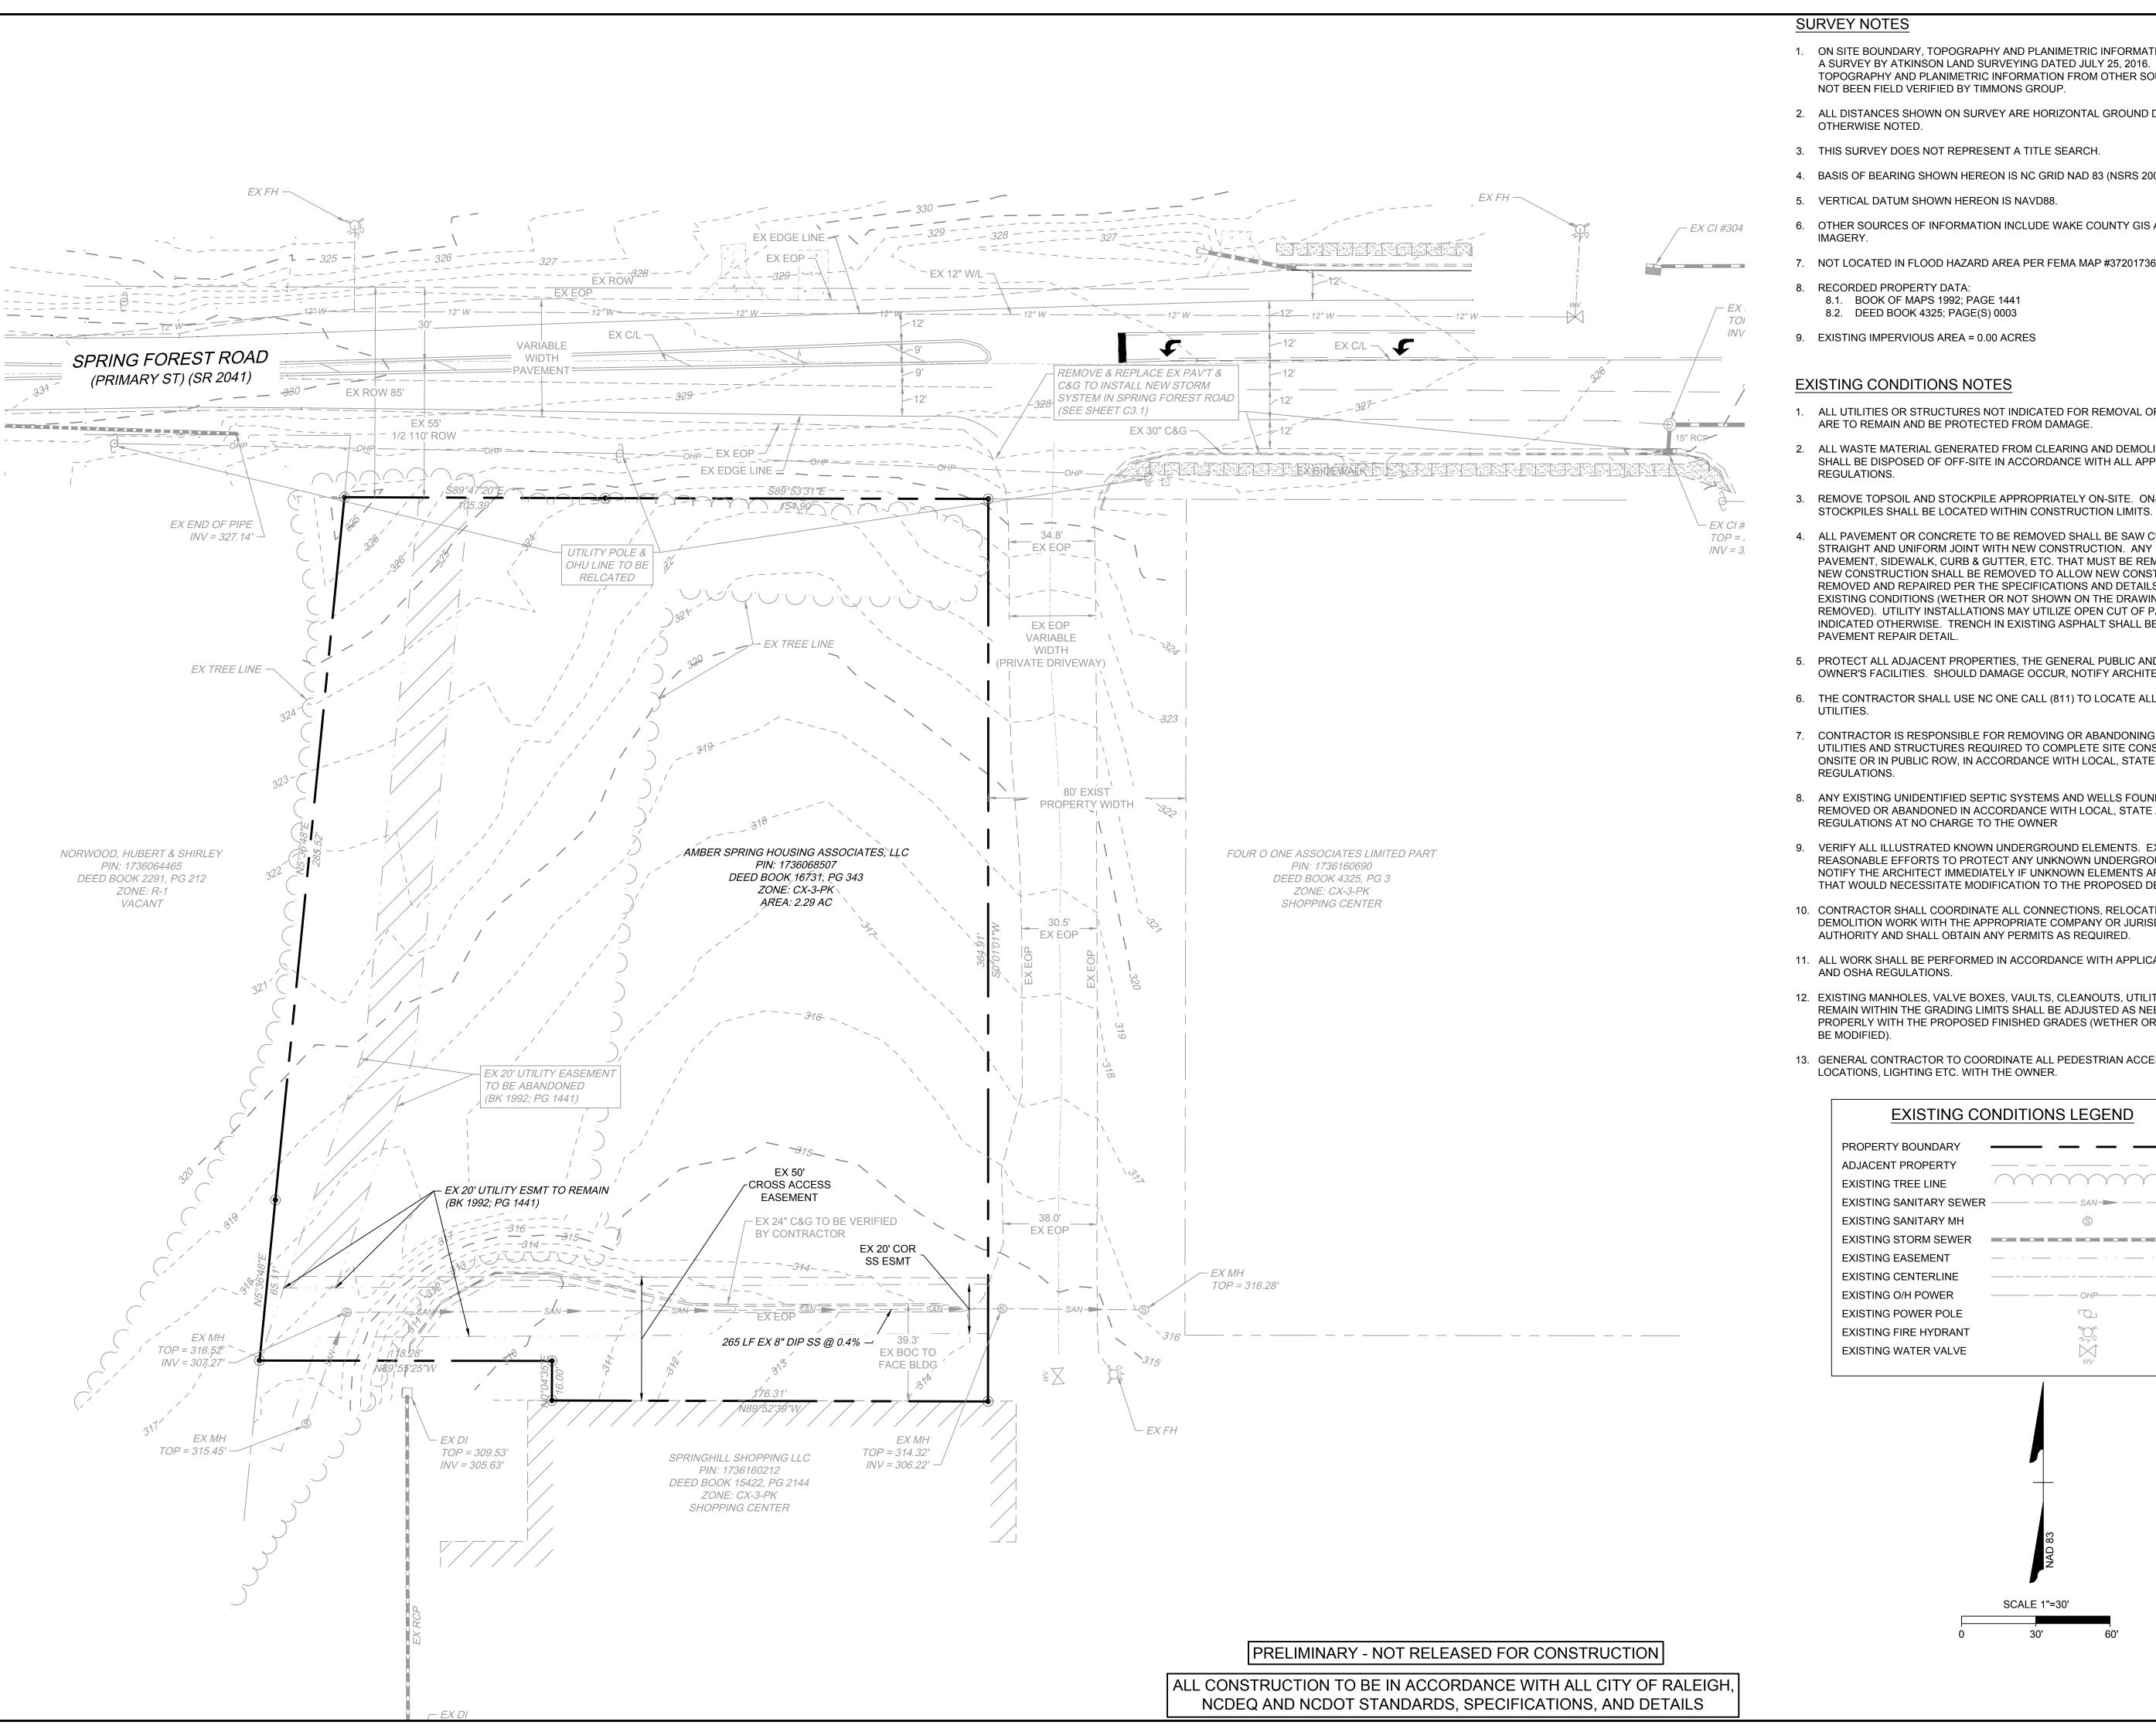

- 1. ON SITE BOUNDARY, TOPOGRAPHY AND PLANIMETRIC INFORMATION IS TAKEN FROM A SURVEY BY ATKINSON LAND SURVEYING DATED JULY 25, 2016. OFFSITE TOPOGRAPHY AND PLANIMETRIC INFORMATION FROM OTHER SOURCES AND HAS NOT BEEN FIELD VERIFIED BY TIMMONS GROUP.
- 2. ALL DISTANCES SHOWN ON SURVEY ARE HORIZONTAL GROUND DISTANCES UNLESS OTHERWISE NOTED.
- 3. THIS SURVEY DOES NOT REPRESENT A TITLE SEARCH.
- 4. BASIS OF BEARING SHOWN HEREON IS NC GRID NAD 83 (NSRS 2007).
- 5. VERTICAL DATUM SHOWN HEREON IS NAVD88.
- 6. OTHER SOURCES OF INFORMATION INCLUDE WAKE COUNTY GIS AND AERIAL
- 7. NOT LOCATED IN FLOOD HAZARD AREA PER FEMA MAP #3720173600J (05-02-2006)
- 8. RECORDED PROPERTY DATA: 8.1. BOOK OF MAPS 1992; PAGE 1441
- 8.2. DEED BOOK 4325; PAGE(S) 0003

EXISTING CONDITIONS NOTES


- 1. ALL UTILITIES OR STRUCTURES NOT INDICATED FOR REMOVAL OR MODIFICATION ARE TO REMAIN AND BE PROTECTED FROM DAMAGE.
- 2. ALL WASTE MATERIAL GENERATED FROM CLEARING AND DEMOLITION ACTIVITIES SHALL BE DISPOSED OF OFF-SITE IN ACCORDANCE WITH ALL APPLICABLE RULES AND
- 3. REMOVE TOPSOIL AND STOCKPILE APPROPRIATELY ON-SITE. ON-SITE TEMPORARY
- 4. ALL PAVEMENT OR CONCRETE TO BE REMOVED SHALL BE SAW CUT TO PROVIDE A STRAIGHT AND UNIFORM JOINT WITH NEW CONSTRUCTION. ANY EXISTING PAVEMENT, SIDEWALK, CURB & GUTTER, ETC. THAT MUST BE REMOVED TO ALLOW NEW CONSTRUCTION SHALL BE REMOVED TO ALLOW NEW CONSTRUCTION SHALL BE REMOVED AND REPAIRED PER THE SPECIFICATIONS AND DETAILS OR TO MATCH EXISTING CONDITIONS (WETHER OR NOT SHOWN ON THE DRAWINGS TO BE REMOVED). UTILITY INSTALLATIONS MAY UTILIZE OPEN CUT OF PAVEMENTS UNLESS INDICATED OTHERWISE. TRENCH IN EXISTING ASPHALT SHALL BE PATCHED PER PAVEMENT REPAIR DETAIL.
- 5. PROTECT ALL ADJACENT PROPERTIES, THE GENERAL PUBLIC AND ALL OF THE OWNER'S FACILITIES. SHOULD DAMAGE OCCUR, NOTIFY ARCHITECT IMMEDIATELY.
- 6. THE CONTRACTOR SHALL USE NC ONE CALL (811) TO LOCATE ALL UNDERGROUND UTILITIES.
- 7. CONTRACTOR IS RESPONSIBLE FOR REMOVING OR ABANDONING ALL EXISTING UTILITIES AND STRUCTURES REQUIRED TO COMPLETE SITE CONSTRUCTION, EITHER ONSITE OR IN PUBLIC ROW, IN ACCORDANCE WITH LOCAL, STATE AND FEDERAL REGULATIONS.
- 8. ANY EXISTING UNIDENTIFIED SEPTIC SYSTEMS AND WELLS FOUND ON SITE SHALL BE REMOVED OR ABANDONED IN ACCORDANCE WITH LOCAL, STATE AND FEDERAL REGULATIONS AT NO CHARGE TO THE OWNER
- 9. VERIFY ALL ILLUSTRATED KNOWN UNDERGROUND ELEMENTS. EXERCISE REASONABLE EFFORTS TO PROTECT ANY UNKNOWN UNDERGROUND ELEMENTS. NOTIFY THE ARCHITECT IMMEDIATELY IF UNKNOWN ELEMENTS ARE DISCOVERED THAT WOULD NECESSITATE MODIFICATION TO THE PROPOSED DESIGN.
- 10. CONTRACTOR SHALL COORDINATE ALL CONNECTIONS, RELOCATION AND DEMOLITION WORK WITH THE APPROPRIATE COMPANY OR JURISDICTION HAVING AUTHORITY AND SHALL OBTAIN ANY PERMITS AS REQUIRED.
- 11. ALL WORK SHALL BE PERFORMED IN ACCORDANCE WITH APPLICABLE LOCAL, STATE AND OSHA REGULATIONS.
- 12. EXISTING MANHOLES, VALVE BOXES, VAULTS, CLEANOUTS, UTILITY POLES ETC. TO REMAIN WITHIN THE GRADING LIMITS SHALL BE ADJUSTED AS NEEDED TO FUNCTION PROPERLY WITH THE PROPOSED FINISHED GRADES (WETHER OR NOT INDICATED TO BE MODIFIED).
- 13. GENERAL CONTRACTOR TO COORDINATE ALL PEDESTRIAN ACCESS PATHS, LOCATIONS, LIGHTING ETC. WITH THE OWNER.

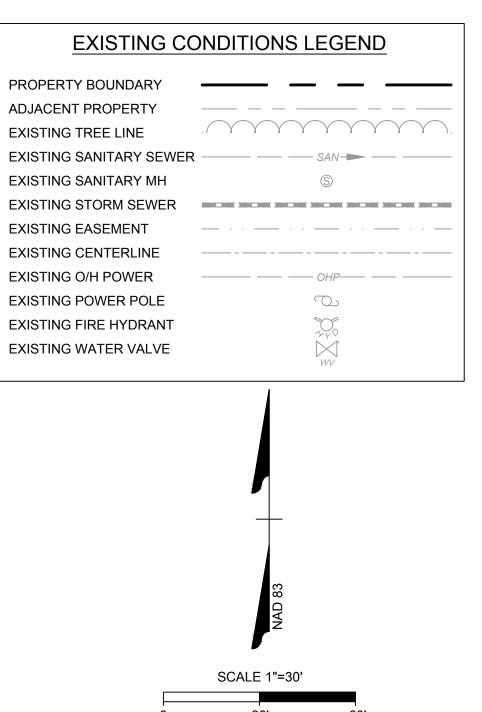

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SHEET NO. C1.0



- 1. ALL CONSTRUCTION SHALL BE IN ACCORDANCE WITH THE CITY OF RALEIGH AND NCDOT STANDARDS AND
- 3. CONTRACTOR SHALL FIELD VERIFY ALL DIMENSIONS, UTILITIES AND GRADES PRIOR TO CONSTRUCTION. CONTRACTOR SHALL NOTIFY THE ENGINEER OF ANY EXISTING DISCREPANCIES PRIOR TO COMMENCING
- 4. AT LEAST 72 HOURS PRIOR TO CONSTRUCTION OR EXCAVATION THE CONTRACTOR SHALL NOTIFY "NORTH CAROLINA ONE CALL" (811) OR (1-800-632-4949) TO HAVE EXISTING UTILITIES LOCATED.
- 5. PARKING SPACES ARE 9.0' WIDE X 18' LONG MINIMUM EXCEPT HANDICAP SPACES WHICH ARE 8.0' WIDE
- 7. CONTRACTOR SHALL NOTIFY THE ENGINEER OF ANY DIMENSIONAL CONFLICTS PRIOR TO THE
- 8. ALL CURB AND GUTTER ONSITE SHALL BE 18" WIDE. ALL CURB AND GUTTER IN THE PUBLIC RIGHT OF
- 9. TRANSITION FROM 30" TO 18" CURB AND GUTTER IS TO OCCUR ON-SITE. THIS TRANSITION SHALL BE 10'
- 10. ALL DISTURBED CURB & GUTTER AND ASPHALT SHALL BE REPLACED PER CITY OF RALEIGH OR NCDOT
- 11. ALL DRIVEWAY DESIGN AND CONSTRUCTION MUST COMPLY WITH THE RALEIGH STREET DESIGN MANUAL.
- 12. NO SIGHT OBSTRUCTING OR PARTIALLY OBSTRUCTING WALL, FENCE, FOLIAGE, BERMING, PARKED VEHICLES OR SIGN BETWEEN THE HEIGHTS OF TWENTY-FOUR (24) INCHES AND EIGHT (8) FEET ABOVE THE CURB LINE ELEVATION, OR THE NEAREST TRAVELED WAY IF NO CURBING EXISTS, SHALL BE PLACED WITHIN A SIGHT TRIANGLE OF A PUBLIC STREET, PRIVATE STREET OR DRIVEWAY CONTAINED EITHER ON
- 1. ALL CONSTRUCTION SHALL BE IN ACCORDANCE WITH CITY OF RALEIGH AND/OR NCDOT STANDARDS.
- 2. THE CONTRACTOR SHALL CONDUCT THE WORK IN A SAFE MANNER AND WITH A MINIMUM AMOUNT OF
- 3. THE CONTRACTOR SHALL BE RESPONSIBLE FOR ALL TRAFFIC CONTROL AND SHALL ADHERE TO THE
- 4. PRIOR TO START OF WORK, A PRE-CONSTRUCTION MEETING MUST BE SET UP WITH THE CONTRACTOR AND CITY OF RALEIGH TRANSPORTATION FIELD SERVICES STAFF. CONTACT ENGINEERING INSPECTIONS
- 5. THE CONTRACTOR SHALL OBTAIN A RIGHT-OF-WAY OBSTRUCTION PERMIT FOR ANY WORK WHICH REQUIRES THE TEMPORARY CLOSURE OF A STREET, TRAVEL LANE, PARKING SPACE OR SIDEWALK FROM
- 6. ANY TEMPORARY STREET CLOSURE MUST BE SUBMITTED A MINIMUM OF 2 WEEKS PRIOR TO START OF WORK. SEE "RIGHT-OF-WAY CLOSURES" ON <u>WWW.RALEIGHNC.GOV</u>. COMPLETE AND SEND THE
- 7. ANY CONTRACTOR OR PROJECT MANAGER THAT IS WORKING ON A CITY PROJECT SHALL SUBMIT A NOTIFICATION TO THE RW OBSTRUCTION APPLICATION FOR EMERGENCY/MAINTENANCE WORK PRIOR TO
- 8. PRIOR TO CONSTRUCTION BEGINNING, ALL SIGNAGE AND TRAFFIC CONTROL SHALL BE IN PLACE.
- 9. THE CONTRACTOR SHALL REPAIR ALL DAMAGED INFRASTRUCTURE IN THE RIGHT-OF-WAY AND RESTORE IT
- 10. THE CONTRACTOR SHALL REPAIR ANY DAMAGES TO ADJACENT PROPERTIES AND RESTORE IT TO
- 11. ALL SIDEWALKS MUST BE ACCESSIBLE TO PERSONS WHO ARE VISUALLY IMPAIRED AND PEOPLE WITH MOBILITY DISABILITIES. PEDESTRIAN EXISTING ROUTES AND ALTERNATE PEDESTRIAN ROUTES DURING CONSTRUCTION WILL BE REQUIRED TO BE COMPLIANT WITH THE PUBLIC RIGHTS OF WAY ACCESSIBILITY GUIDELINES (PROWAG), 2010 ADA STANDARDS FOR ACCESSIBLE DESIGN AND THE MANUAL ON UNIFORM
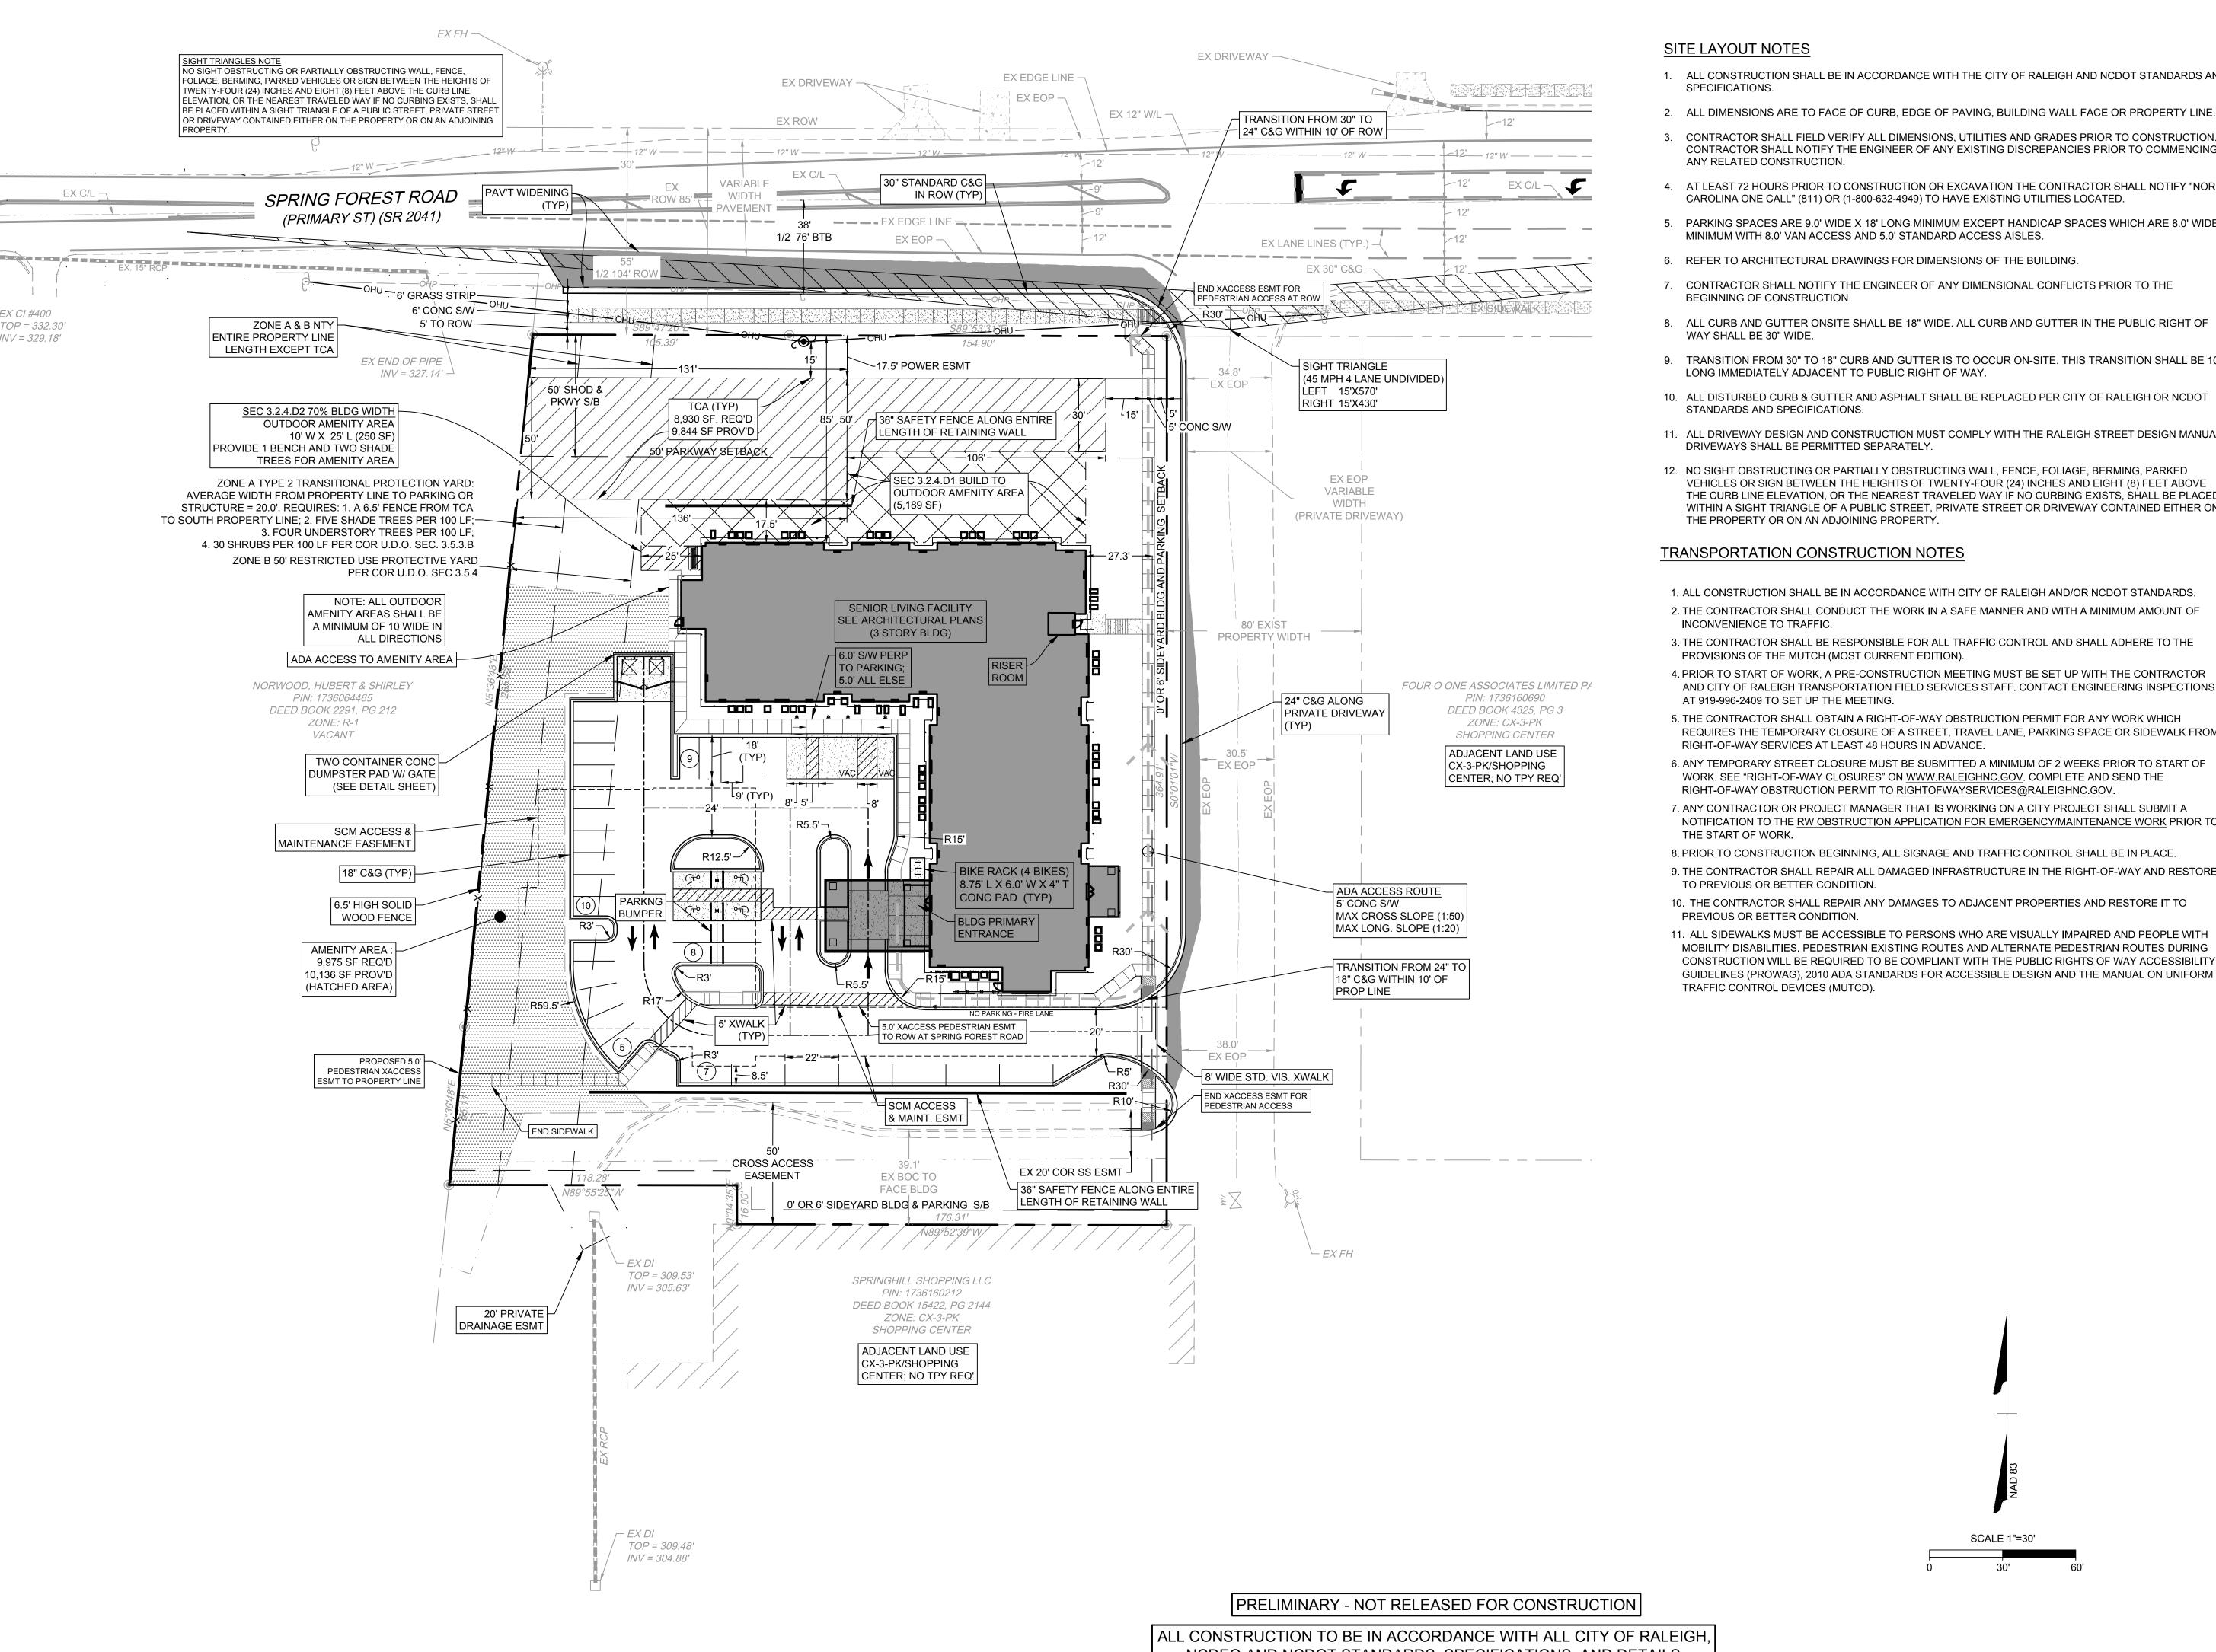
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09/14/16 DRAWN BY P. BARBEAU


DESIGNED BY P. BARBEAU CHECKED BY R. BAKER

SCALE PER PLAN

36311

SHEET NO. C2.0

NCDEQ AND NCDOT STANDARDS, SPECIFICATIONS, AND DETAILS

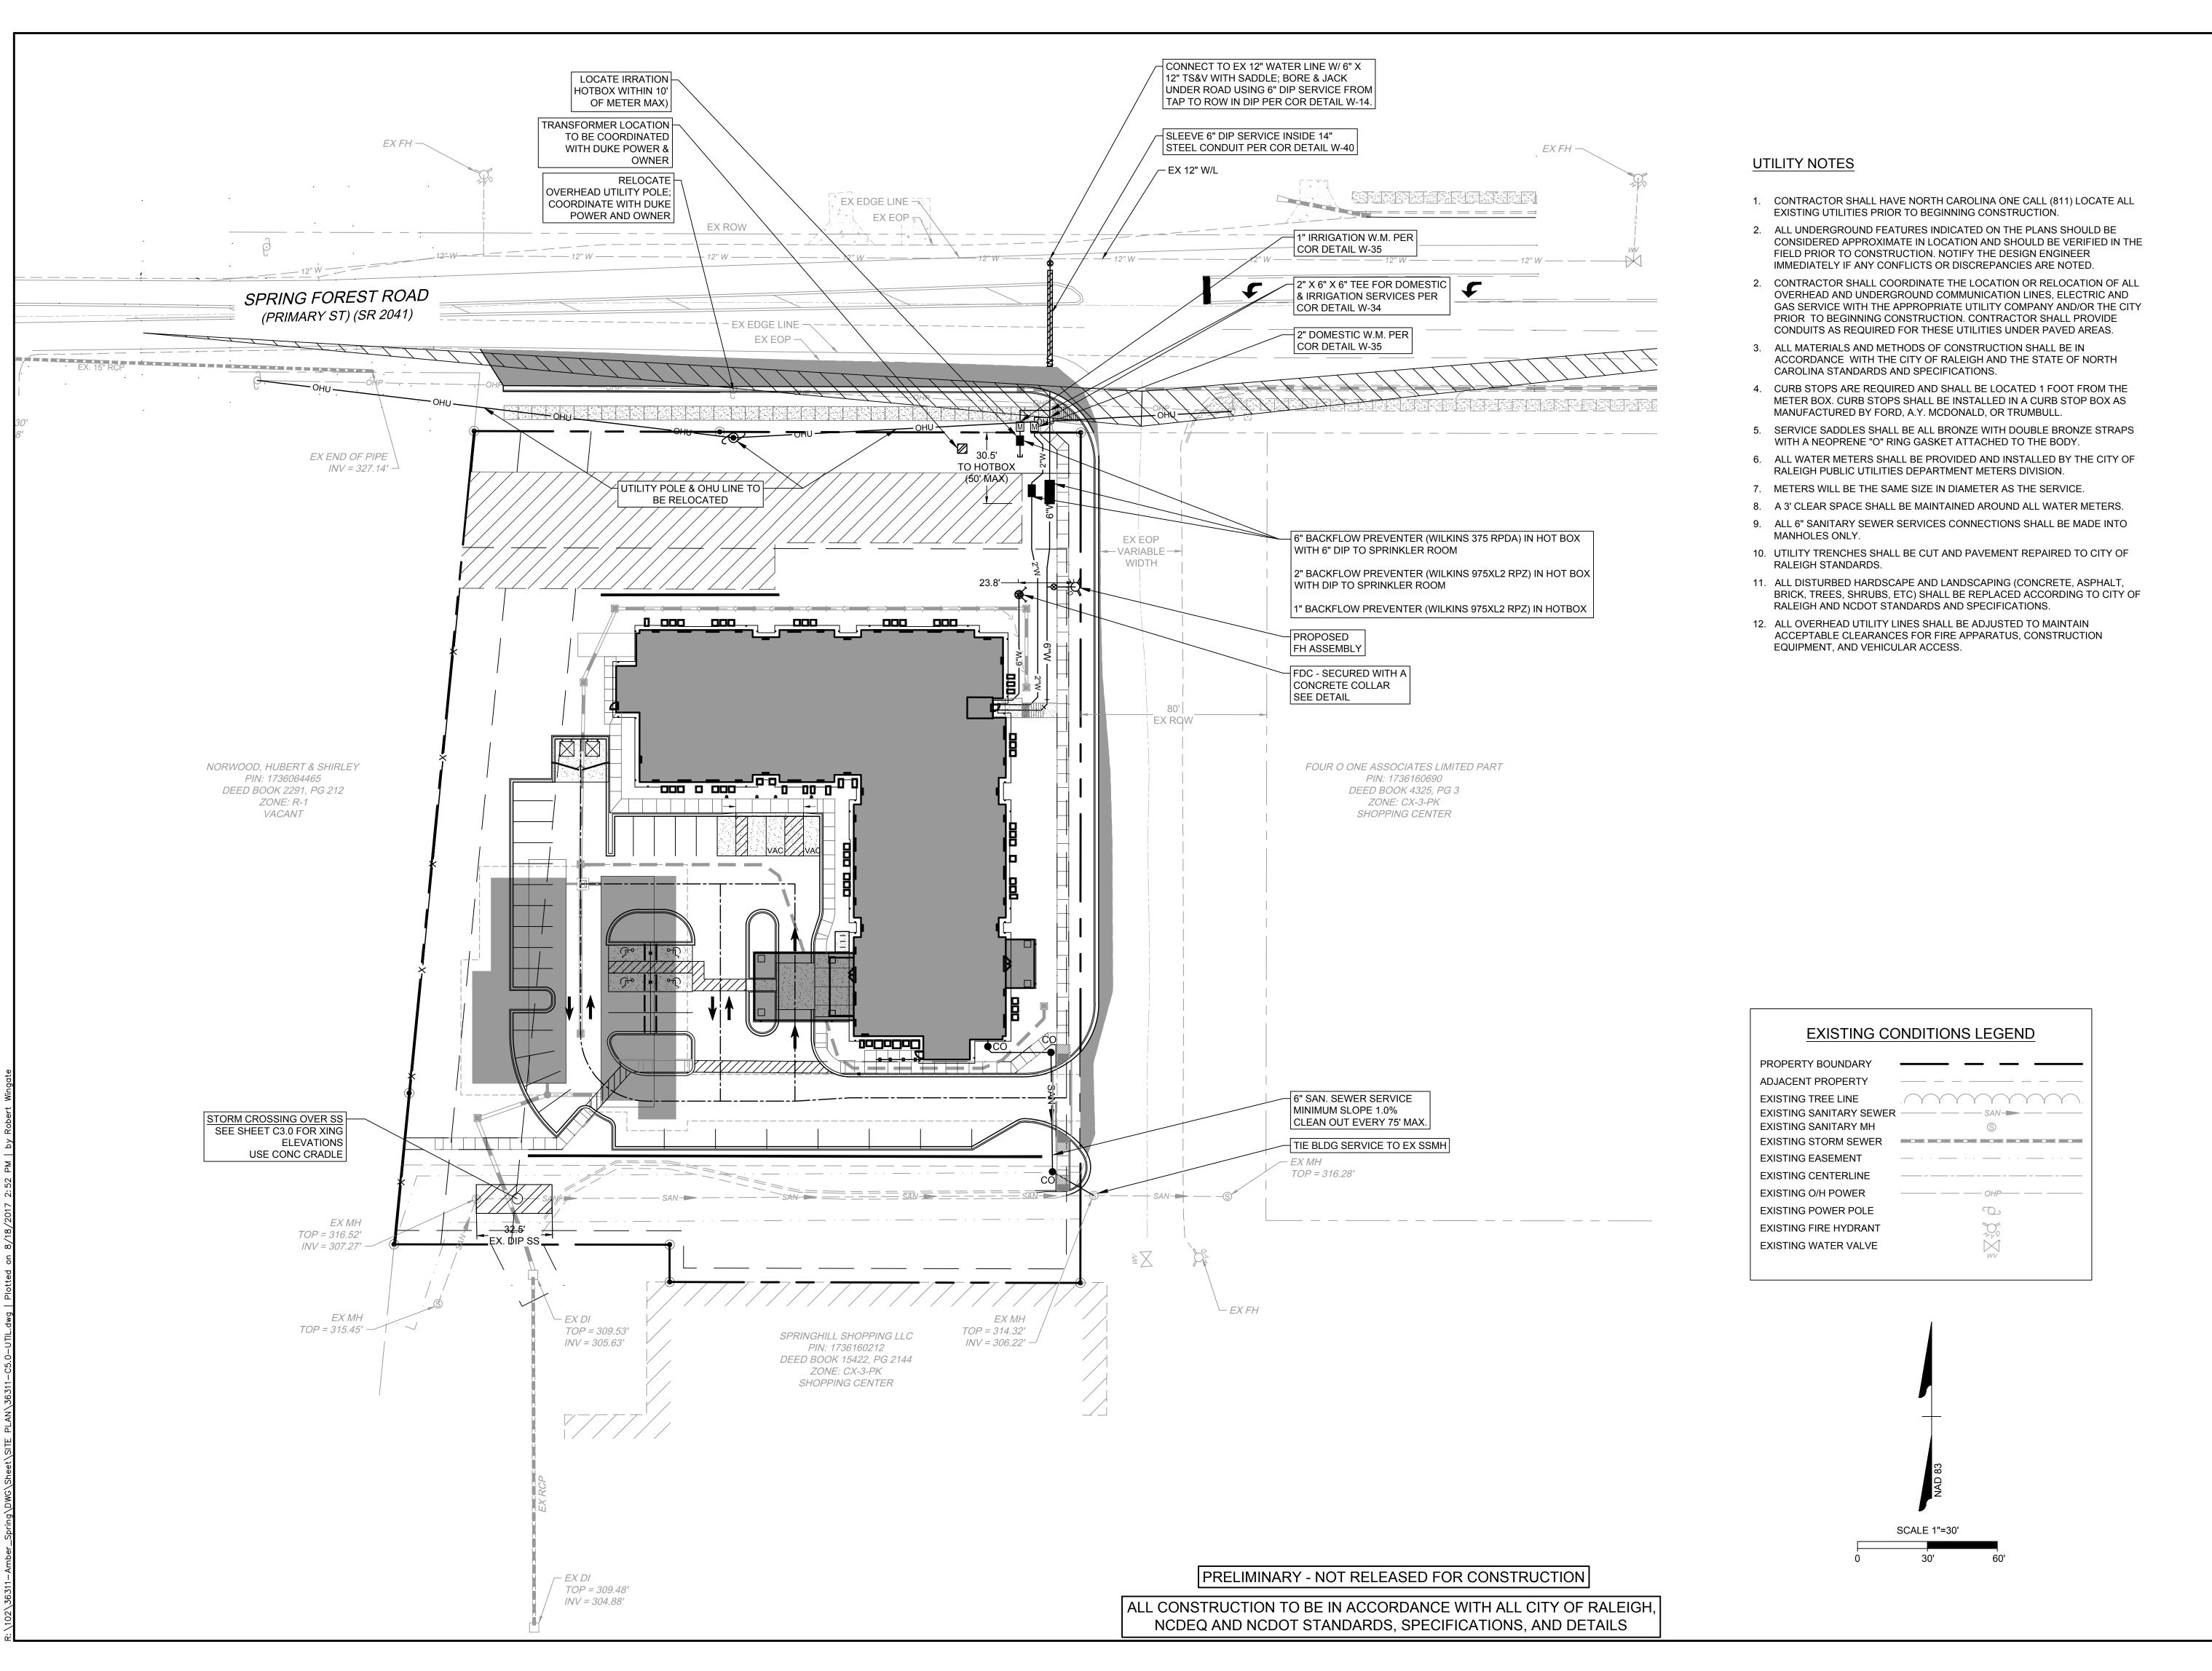

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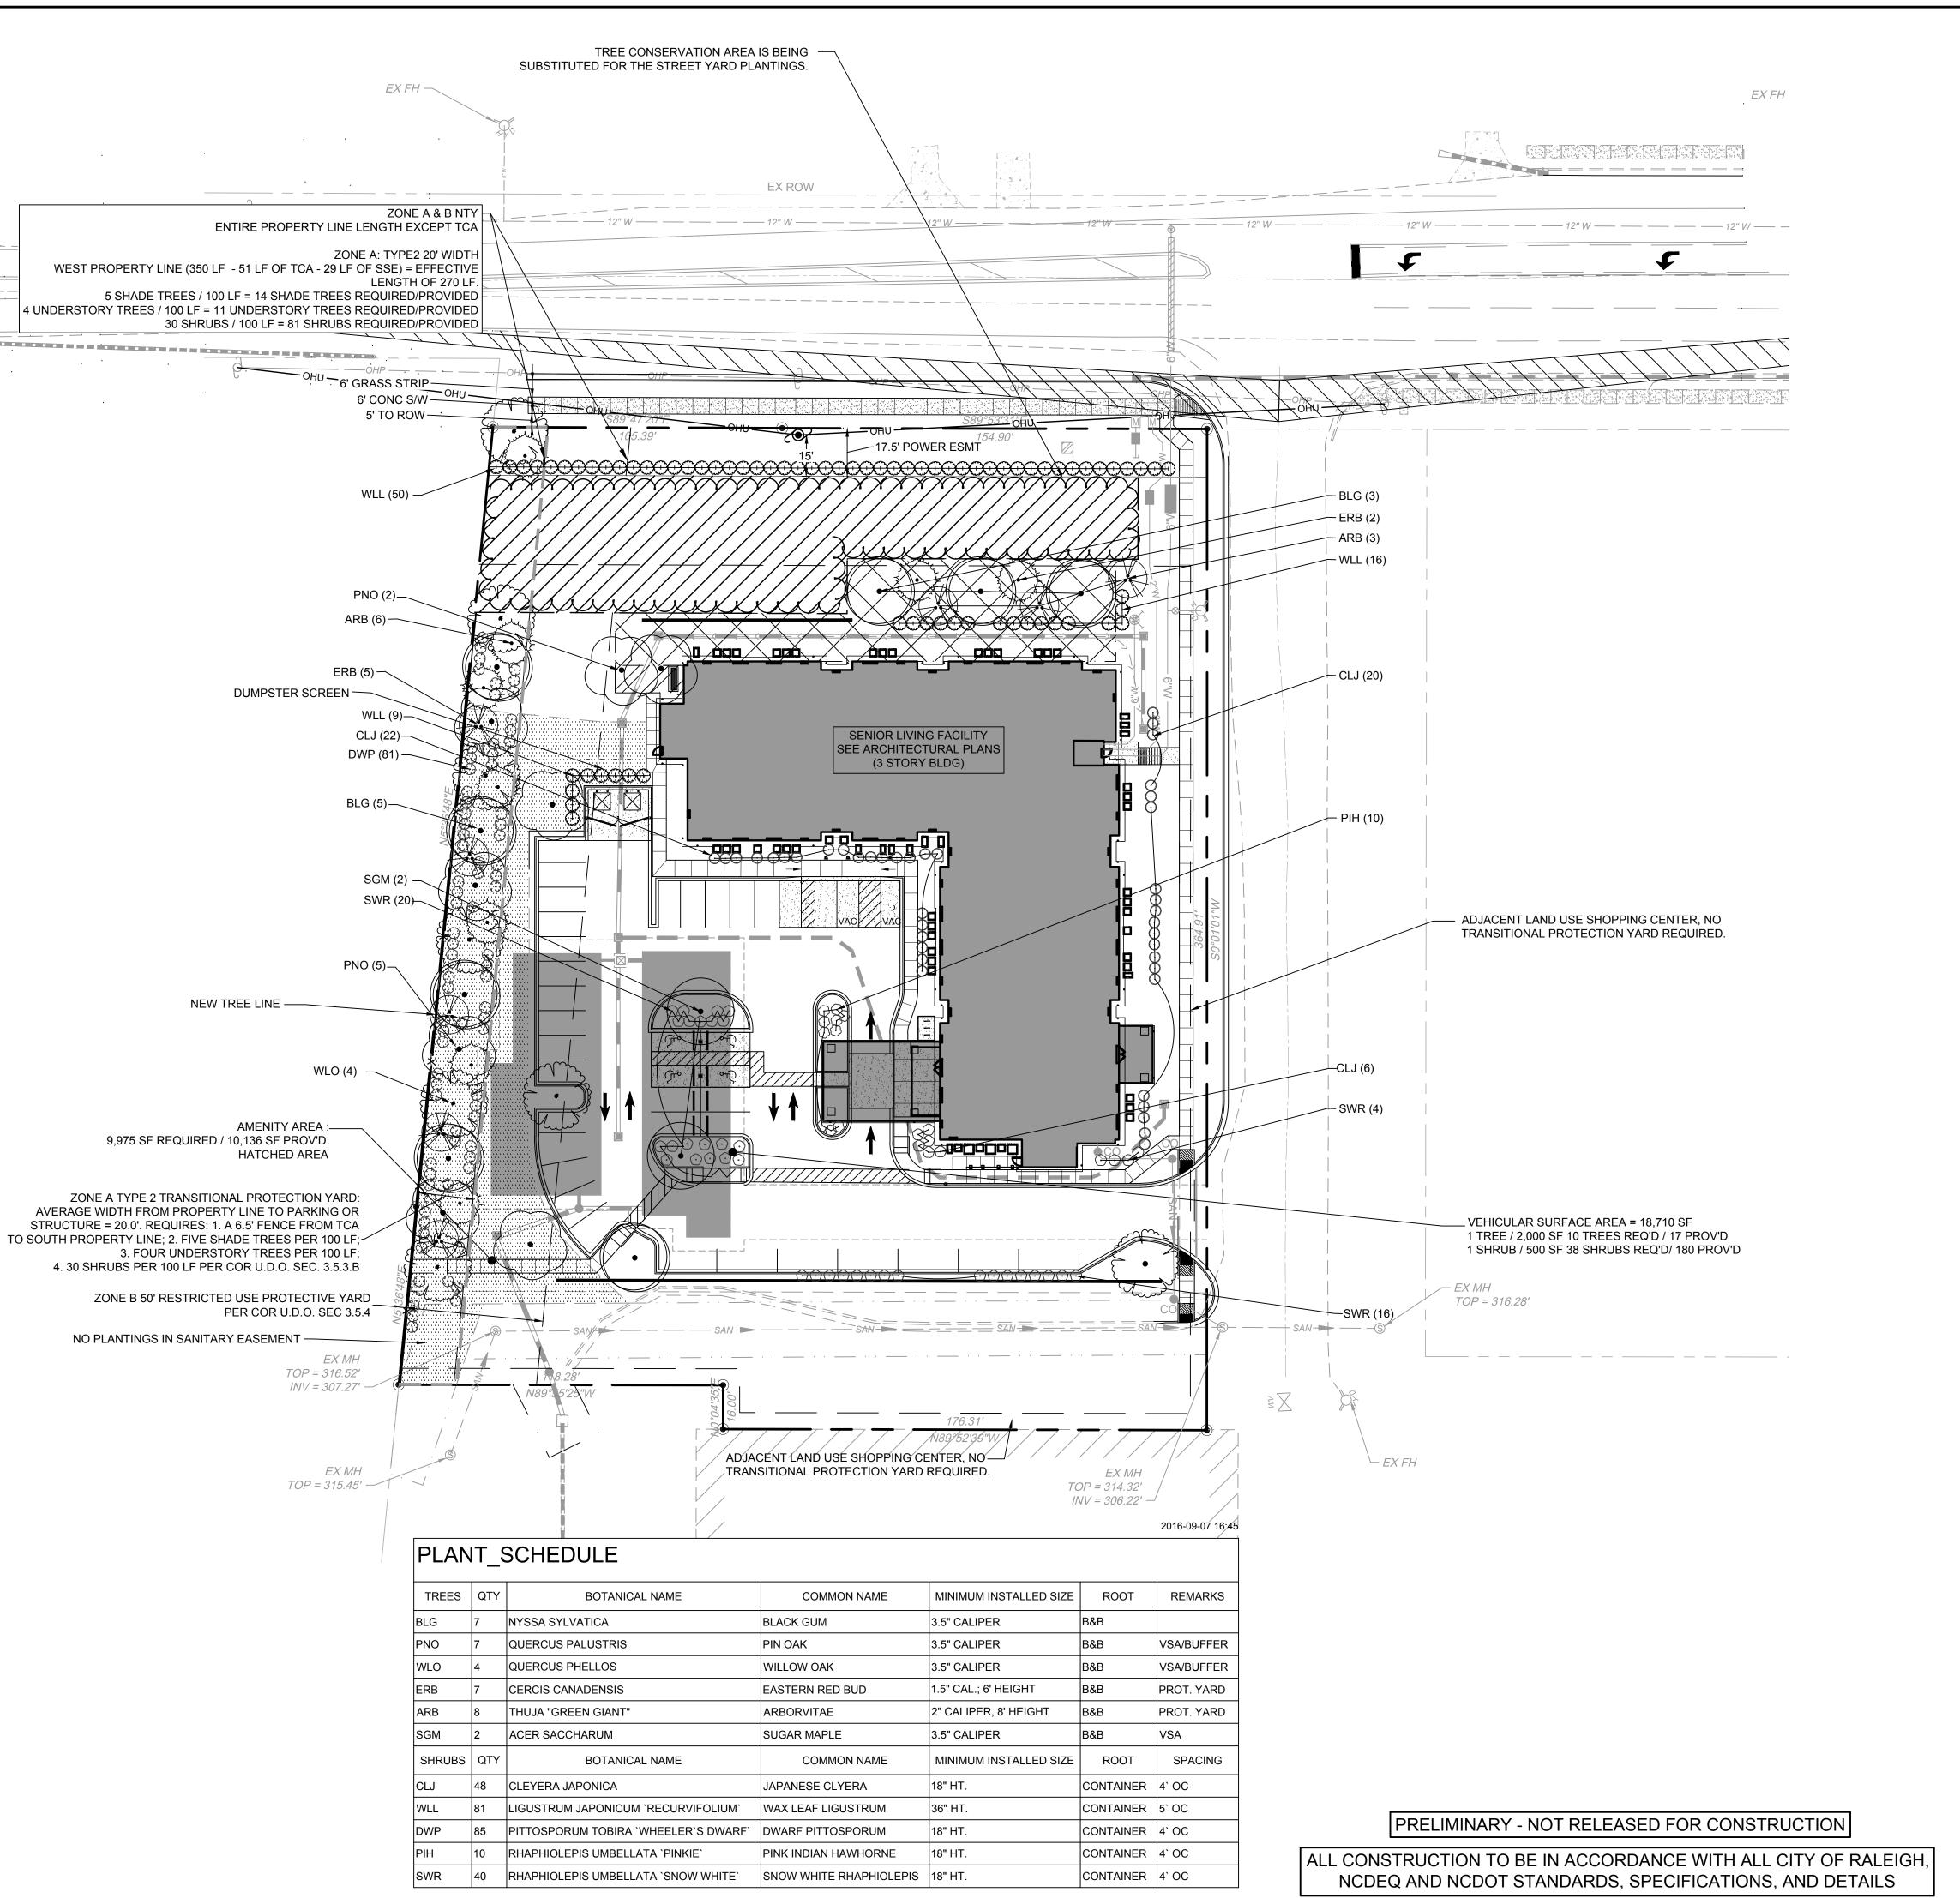
09/14/16 DRAWN BY P. BARBEAU

DESIGNED BY P. BARBEAU CHECKED BY R. BAKER

SCALE PER PLAN

36311

SHEET NO. C5.0



GENERAL NOTES

- PRIOR TO THE COMMENCEMENT OF ANY ACTIVITIES REQUIRING A BUILDING OR ZONING PERMIT AN ON-SITE PRE CONSTRUCTION CONFERENCE SHALL TAKE PLACE WITH THE DEVELOPER AND THE ADMINISTRATOR TO REVIEW PROCEDURES FOR THE PROTECTION AND MANAGEMENT OF ALL LANDSCAPE ELEMENTS THAT ARE TO REMAIN AS IDENTIFIED ON THE LANDSCAPE PLAN.
- CALL 811 FOR LOCATION OF ALL UTILITY LINES. TREES SHALL BE LOCATED A MINIMUM OF 5 FEET FROM SEWER/WATER CONNECTIONS. NOTIFY LANDSCAPE ARCHITECT OF CONFLICTS. • VERIFY ALL PLANT MATERIAL QUANTITIES ON THE PLAN PRIOR TO BIDDING, PLANT LIST TOTALS ARE FOR CONVENIENCE ONLY AND SHALL BE VERIFIED PRIOR TO BIDDING.
- PROVIDE PLANT MATERIALS OF QUANTITY, SIZE, GENUS, SPECIES, AND VARIETY INDICATED ON PLANS. ALL PLANT MATERIALS AND INSTALLATION SHALL COMPLY WITH RECOMMENDATIONS AND REQUIREMENTS OF ANSI Z60.1 "AMERICAN STANDARD FOR NURSERY STOCK". IF SPECIFIED PLANT MATERIAL IS NOT OBTAINABLE, SUBMIT PROOF OF NON AVAILABILITY TO THE ARCHITECTS, TOGETHER WITH PROPOSAL FOR USE OF EQUIVALENT MATERIAL.
- PROVIDE AND INSTALL ALL PLANTS AS IN ACCORDANCE WITH DETAILS AND CONTRACT SPECIFICATIONS.

INSTALLATION

- LANDSCAPE ARCHITECT RESERVES THE RIGHT TO REJECT ANY PLANTS AND MATERIALS THAT ARE IN AN UNHEALTHY OR UNSIGHTLY CONDITION, AS WELL AS PLANTS AND MATERIALS THAT DO NOT CONFORM TO ANSI Z60.1 "AMERICAN STANDARD FOR NURSERY STOCK". LABEL AT LEAST ONE TREE AND ONE SHRUB OF EACH VARIETY AND CALIPER WITH A
- SECURELY ATTACHED, WATERPROOF TAG BEARING THE DESIGNATION OF BOTANICAL AND
- INSTALL LANDSCAPE PLANTINGS AT ENTRANCES/EXITS AND PARKING AREAS ACCORDING TO PLANS SO THAT MATERIALS WILL NOT INTERFERE WITH SIGHT DISTANCES. • CONTRACTOR IS RESPONSIBLE FOR WATERING ALL PLANT MATERIAL DURING INSTALLATION AND UNTIL FINAL INSPECTION AND ACCEPTANCE BY OWNER. CONTRACTOR SHALL NOTIFY OWNER OF CONDITIONS WHICH AFFECTS THE GUARANTEE.

- UPON COMPLETION OF LANDSCAPE INSTALLATION, THE LANDSCAPE CONTRACTOR SHALL NOTIFY THE GENERAL CONTRACTOR WHO WILL VERIFY COMPLETENESS, INCLUDING THE REPLACEMENT OF ALL DEAD PLANT MATERIAL. CONTRACTOR IS RESPONSIBLE FOR SCHEDULING A FINAL INSPECTION BY THE LANDSCAPE ARCHITECT.
- ALL EXTERIOR PLANT MATERIALS SHALL BE GUARANTEED FOR ONE FULL YEAR AFTER DATE OF FINAL INSPECTION AGAINST DEFECTS INCLUDING DEATH AND UNSATISFACTORY GROWTH. DEFECTS RESULTING FROM NEGLECT BY THE OWNER, ABUSE OR DAMAGE BY OTHERS, OR UNUSUAL PHENOMENA OR INCIDENTS WHICH ARE BEYOND THE CONTRACTORS CONTROL ARE NOT THE RESPONSIBILITY OF THE CONTRACTOR.
- PLANT MATERIAL QUANTITIES AND SIZES WILL BE INSPECTED FOR COMPLIANCE WITH APPROVED PLANS BY A SITE PLAN REVIEW AGENT OF THE PLANNING DEPARTMENT PRIOR TO THE RELEASE OF THE CERTIFICATE OF OCCUPANCY.
- REMOVE ALL GUY WIRES AND STAKES 12 MONTHS AFTER INSTALLATION.

LANDSCAPE NOTES


- 1. KEY REFERS TO PLANT LIST. WHERE THERE IS ONLY A KEY, THE QUANTITY IS ONE. WHERE THE KEY IS FOLLOWED BY A NUMBER, THE NUMBER IS THE QUANTITY REQUIRED FOR THE INDICATED PLANT BED.
- 2. LOCATE PLANTS AND PLANTING BEDS BY USING SCALED DIMENSIONS FROM STREET, PROPERTY LINES, ETC. DIMENSIONS ON STREET YARDS, BUFFERS AND LANDSCAPE AREAS ARE A MINIMUM WIDTH AND SHALL NOT BE REDUCED.
- 3. ALL PLANTS SHALL MEET OR EXCEED THE MINIMUM STANDARDS SET BY THE U.S.D.A. STANDARD FOR NURSERY STOCK SPONSORED BY THE AMERICAN ASSOCIATION OF NURSERYMEN, INC., WASHINGTON, D.C.
- 4. MULCH ALL TREES AND PLANTING BEDS AS NOTED ON DRAWING. ALL PLANT GROUPINGS ARE CONSIDERED PLANTING BEDS.
- 5. LANDSCAPE CONTRACTOR SHALL VERIFY UTILITY AND STORM DRAINAGE LOCATIONS IN THE FIELD PRIOR TO BEGINNING CONSTRUCTION. ANY CONFLICTS WITH UTILITIES SHALL BE
- 6. APPLY PRE-EMERGENT HERBICIDE TO ALL PLANTING BEDS PER MANUFACTURER'S SPECIFICATIONS.
- 7. LANDSCAPE CONTRACTOR SHALL SEED AREAS DESIGNATED ON PLAN WITH STATESMAN BLEND FESCUE BY SOUTHERN STATES SEED, OR APPROVED EQUAL.
- 8. THE SITE SHALL BE STABILIZED AND SEEDED PRIOR TO THE ISSUANCE OF A CERTIFICATE OF
- 9. THE SIZE OF THE PLANTING AREA AND SIZE OF PLANT MATERIAL AT MATURITY SHALL ALLOW
- 10. ALL TREE PROTECTION FENCING SHALL BE MAINTAINED UNTIL ALL SITE WORK IS COMPLETED. THE FENCING SHALL BE REMOVED PRIOR TO THE FINAL SITE INSPECTION FOR THE CERTIFICATE OF OCCUPANCY (CO).
- 11. REQUIRED STREET TREES THAT ARE LOCATED WITHIN A SIGHT DISTANCE TRIANGLE SHALL BE LIMBED UP TO 8' TO PREVENT THE OBSTRUCTION OF VISION.
- 12. NO CANOPY TYPE TREES ARE TO BE PLACED IN PUBLIC UTILITY EASEMENTS.

FOR A 2.5' BUMPER OVERHANG FROM THE BACK OF CURB.

- 13. SCREEN WALLS ARE NON-STRUCTURAL WALLS THAT PROVIDE A VISUAL BARRIER BETWEEN ADJACENT PROPERTIES.
- 14. RETAINING WALL TOP OF WALL (TW) GRADES ARE 0.5 FT ABOVE THE ADJACENT GRADE.

SIGHT DISTANCE

- I. NO SIGHT OBSTRUCTING OR PARTIALLY OBSTRUCTING WALL, FENCE FOLIAGE, BERMING, PARKED VEHICLES OR SIGN BETWEEN THE HEIGHTS OF TWENTY-FOUR INCHES AND EIGHT FEET ABOVE THE CURB LINE ELEVATION, OR THE NEAREST TRAVELED WAY IF NO CURBING EXISTS, SHALL BE PLACED WITHIN A SIGHT TRIANGLE OF A PUBLIC STREET, PRIVATE STREET OR DRIVEWAY CONTAINED EITHER ON THE PROPERTY OR ON AN ADJOINING
- 2. SIGHT DISTANCE IS DETERMINED AS PER THE NCDOT'S POLICY ON STREET AND DRIVEWAY ACCESS TO NORTH
- THE INTERSECTION SIGHT DISTANCE IS CALCULATED BY THE FOLLOWING: SITE ENTRANCES (CITY OF RALEIGH MANUAL CALCULATION) ISD = 100 x Vmajor (Design Speed) Per 10 mph ISD = 100 x 10 / 10 = 100 FEET

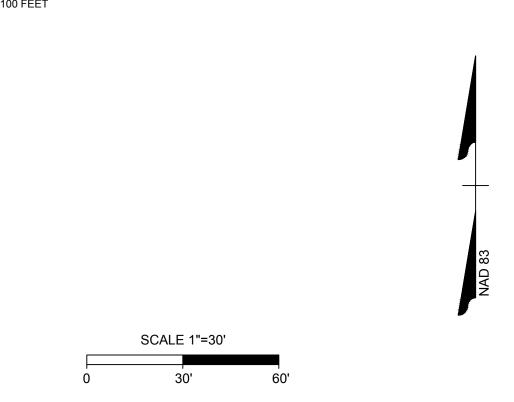

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09/14/16 DRAWN BY P. BARBEAU

DESIGNED BY P. BARBEAL CHECKED BY

R. BAKER SCALE

PER PLAN

JOB NO. 36311 SHEET NO. C6.0

SPRING

MBER

Rear

ELEVATIONS

A2.1



MASONRY CONTROL JOINTS TO BE PROVIDED AT ALL INSIDE CORNERS, AS WELL AS WHERE INDICATED ON ELEVATIONS.

MINIMUM THICKNESS OF ALL VINYL SIDING TO BE .044".

- SOFFITS TO BE PRE-FINISHED HARDIE COLORPLUS OR EQUAL. ROOFER TO INSTALL PERMA BOOTS "WEATHERWOOD" AT ALL PLUMBING VENT ROOF PENETRATIONS.
- SEE ROOF PLAN ON A1.4 FOR DOWNSPOUT LOCATIONS.

ALL WORK TO COMPLY WITH THE NCHFA'S 2016 QAP.

ALL VINYL SIDING TO HAVE A FLAME SPREAD VALUE OF 20 OR LESS.

NOTATION LEGEND

M.C.J. = MASONRY CONTROL JOINT F.O.M = FACE OF MANSONRY

SPRING FOREST ROAD

Left

-STANDING SEAM METAL ROOF

-ELECTRICAL CHASE--FRAMED WALL TO BE

FLUSH WITH BRICK FACE, THIS SIDE ONLY

-BRICK ROWLOCK, RECESSED 3/4" AT

—CONTINUOUS RIDGE VENT, TYP.

SHINGLES W/ METAL DRIP EDGE

-30 YEAR ANTIFUNCAL DIMENSIONAL ROOF

—6" ALUMINUM GUTTERS W/ GUARDS AND

STAIRWELL AND ELEC. CHASE

DOWNSPOUTS

-CONTINUOUS RIDGE VENT, TYP.

SHINGLES W/ METAL DRIP EDGE

DOWNSPOUTS

-MASONRY CONTROL

JOINTS AT EDGES

OF BALC. FLOOR

Ave. Grade Plan

-0' - 9"

-30 YEAR ANTIFUNCAL DIMENSIONAL ROOF

-6" ALUMINUM GUTTERS W/ GUARDS AND

REAR PATIO

−MASONRY CONTROL JOINT`

-PROJECTING ROWLOCK SILL

-PROJECTING ROWLOCK SILL

OVER FLUSH SOLDIER COURSE

A2.3 /

2nd Clg. Brg. 18' - 4 1/2"

1st Clg. Brg. 8' - 1 1/2"

2nd Clg. Brg. 18' - 4 1/2"

1st Clg. Brg. 👝

8' - 1 1/2"

Truss Bearing 🕋

3rd Floor Plan

2nd Floor Plan 🕋

1st Floor Plan 🕋

-0' - 9"

Truss Bearing

28' - 7 1/2"

3rd Floor Plan 20' - 6"

2nd Floor Plan

1st Floor Plan 🕋


Ave. Grade Plan

-0' - 9"

🔪 Ave. Grade Plan 🚁

28' - 7 1/2"

20' – 6"

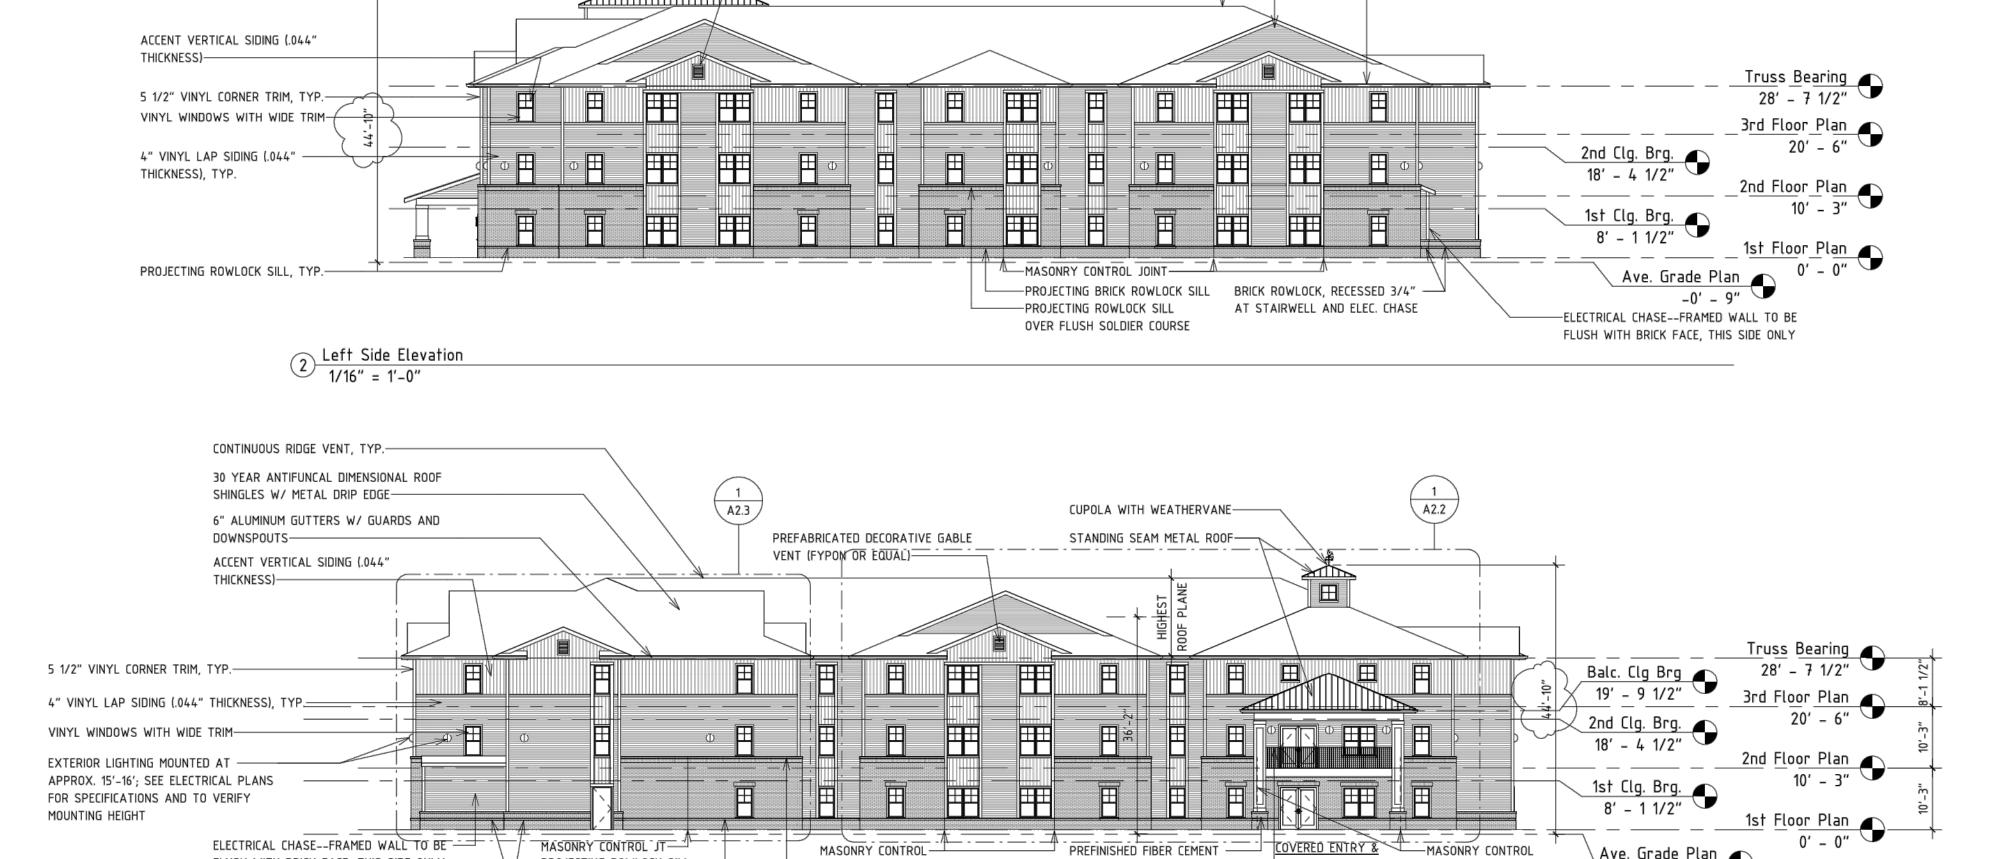

CUPOLA WITH WEATHERVANE-

-STANDING SEAM METAL ROOF-

ENTRY

-PREFABRICATED DECORATIVE GABLE

VENT (FYPON OR EQUAL)

 $^{
m J}$ Brick veneer-

FLUSH SOLDIER COURSE

PROJECTING BRICK ROWLOCK SILL-

PROJECTING ROWLOCK SILL OVER —

CLAD COLUMNS ON BRICK BASE

REINFORCED VINYL RAILING -

AT 42" HT.

PORTE COCHERE

-CUPOLA WITH WEATHERVANE

-STANDING SEAM METAL ROOF

PREFINISHED FIBER

ON BRICK BASE

CEMENT CLAD COLUMNS

-PREFABRICATED DECORATIVE GABLE

MASONRY CONTROL

VENT (FYPON OR EQUAL)

PREFINISHED FIBER CEMENT CLAD —

REINFORCED VINYL RAILING AT 42" HT.-

COLUMNS ON BRICK BASE

A2.3

M.C.J. (ALONG

AT PATIO)

EDGES OF BLKHDS

MASONRY CONTROL JT-

FLUSH SOLDIER COURSE

PROJECTING ROWLOCK SILL ---

PROJECTING ROWLOCK SILL OVER —

CONTINUOUS RIDGE VENT, TYP.—

DOWNSPOUTS-

THICKNESS)----

Balc. Clg Brg
19' - 9 1/2"

4" VINYL LAP SIDING (.044" THICKNESS), TYP.

5 1/2" VINYL CORNER TRIM, TYP.-

VINYL WINDOWS WITH WIDE TRIM-

ACCENT VERTICAL SIDING (.044"

5 1/2" VINYL CORNER TRIM, TYP.—

VINYL WINDOWS WITH WIDE TRIM-

4" VINYL LAP SIDING (.044" THICKNESS), TYP.

ELECTRICAL CHASE--FRAMED WALL TO BE

FLUSH WITH BRICK FACE, THIS SIDE ONLY

THICKNESS)—

30 YEAR ANTIFUNCAL DIMENSIONAL ROOF SHINGLES W/ METAL DRIP EDGE, TYP.—

6" ALUMINUM GUTTERS W/ GUARDS AND

Right Side Elevation
1/16" = 1'-0"

3 Rear Elevation
1/16" = 1'-0"

FLUSH WITH BRICK FACE, THIS SIDE ONLY

1 Front Elevation 1/16" = 1'-0"

BRICK ROWLOCK, RECESSED 3/4" -

AT STAIRWELL AND ELEC. CHASE

PREFABRICATED DECORATIVE GABLE

VENT (FYPON OR EQUAL)-

ACCENT VERTICAL SIDING (.044"